
NON ELEVATED BLEACHER

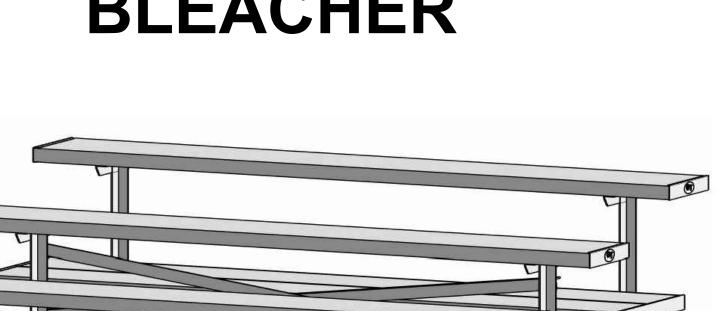

ALUMINUM 3 ROW x 7'-6" - UNIVERSAL SERIES

MODEL
LU-037.5AD

SCERTIFIED STABRICATOR

GT GRANDSTANDS*

COVER SHEET 3 ROW BLEACHER 5" RISER/12" SEATS

LU-037.5AD OPTIONAL -MS (MUD SILL) OPTIONAL -RB (RUBBER BUMPERS)

DRAWN BY
MME
CHECKED BY
TLC
DATE
II/01/2016
SCALE


CS.1 - COVER SHEE

SP.1 — BLEACHER SEATING PLAN


FB1 - FRAME AND BRACING BA.1 - BLEACHER ASSEMBLY

CS.1

LU-037.5AD

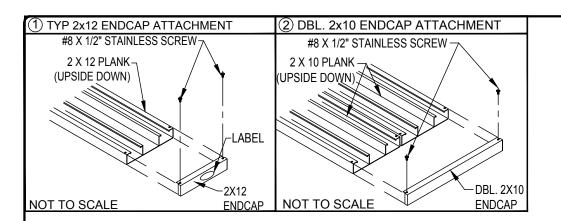



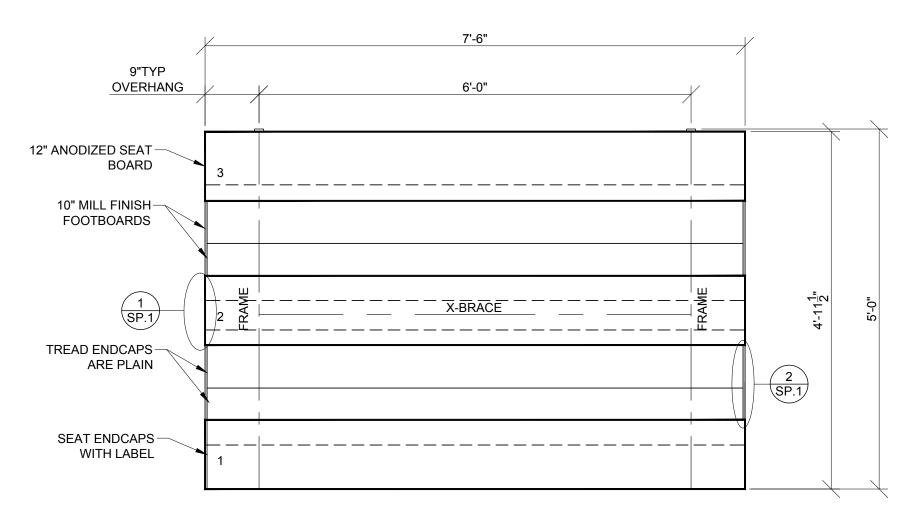

SEATING PLAN

SCALE: 3/4" = 1' - 0"

LOCAL CODES AND SPECIFICATIONS WILL VARY FROM REGION TO REGION AND WILL ALSO CHANGE OVER TIME. IT IS THE BUYER'S RESPONSIBILITY TO CHECK LOCAL CODES FOR COMPLIANCE.


SEATING PLAN
3 ROW BLEACHER
6" RISER/12" SEAT

LU-037.5AD LU SERIES

DRAWN BY
MME
CHECKED BY
TLC
DATE
II/01/2016
SCALE
AS SHOWN
JOB NO.

LU-037.5AD

SP.1

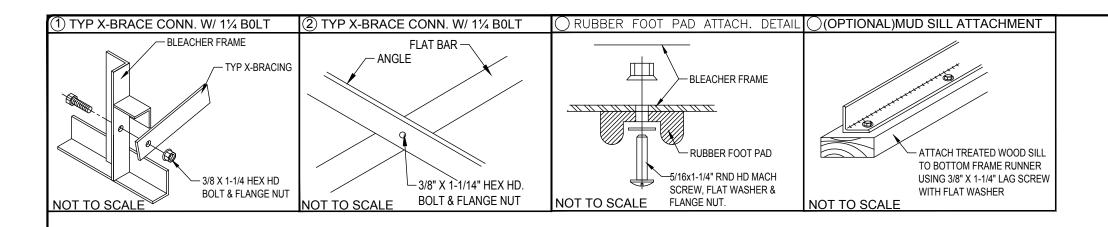





FRAME AND BRACE 3 ROW BLEACHER 6" RISER/12" SEAT

LU-037.5AD OPTIONAL -MS (MUD SILL) OPTIONAL -RB (RUBBER BUMPER)

TLC

DATE

II/01/2016

SCALE

AS SHOWN

JOB NO.

DRAWN BY
MME
CHECKED BY

LU-037.5AD DWG NO. FB.1

FA-03_LRN AG-060114
ANGLE

2
AF-060114
FB.1
FB.1
FB.1


PC
P

FRAME SECTION SCALE: NTS

PRE-ASSEMBLE X-BRACE SETS. EACH SET CONSISTS OF A ANGLE AND FLAT BAR. PLACE THE PIECES TOGETHER AT THE FLAT SIDE AND CONNECT USING A 3/8" X 1 1/4 HEX BOLT & FLANGE NUT.

SCERTIFIED STABRICATOR

NOTE: LEAVE FLANGE NUT LOOSE UNTIL CLIPS HAVE BEEN SECURED TO PLANKS.

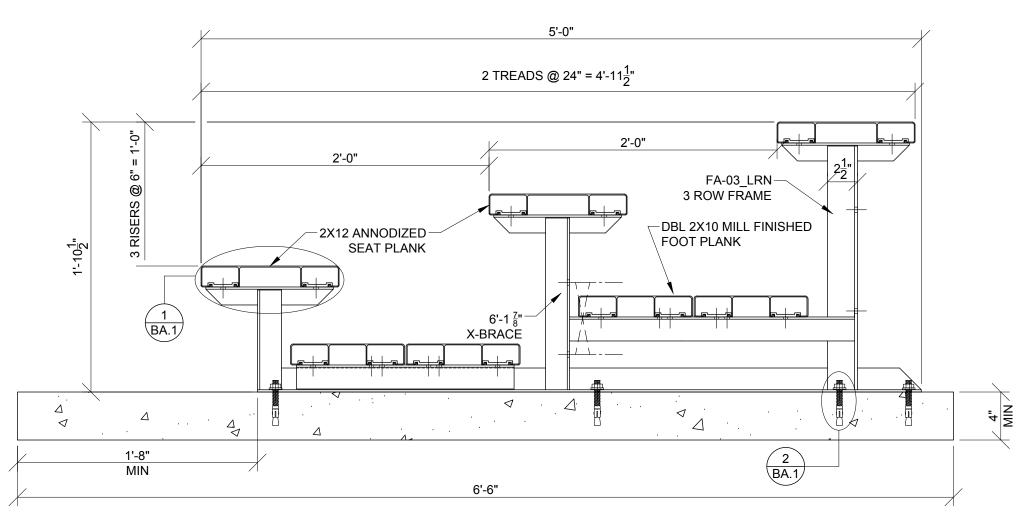

BLEACHER ASSEMBLY

SCALE: 1 1/2" = 1' - 0"

*CONCRETE WEDGE ANCHORS NOT INCLUDED WITH ALL UNITS. IF USING OTHER ANCHORING SYSTEM, SKIP THIS STEP AND REFER TO INSTRUCTIONS SPECIFIC TO THE ANCHORING SYSTEM PURCHASED FOR YOUR UNIT. SEE PRINT FP.1 (INCLUDED IN THIS PACKET) FOR GENERAL CONCRETE FOUNDATION SPECIFICATIONS.

Plant City, Florida Phone: 813-305-1 Fax: 813-305-1 Phoyers company Www. gtgrandstan


BLEACHER ASSEMBLY 3 ROW BLEACHER 6" RISER/I2" SEAT

LU-037.5AD (OPTIONAL CONCRETE FOUNDATION) LU SERIES

DRAWN BY
MME
CHECKED BY
TLC
DATE
II/01/2016
SCALE
AS SHOWN

LU-037.5AD

BA.1

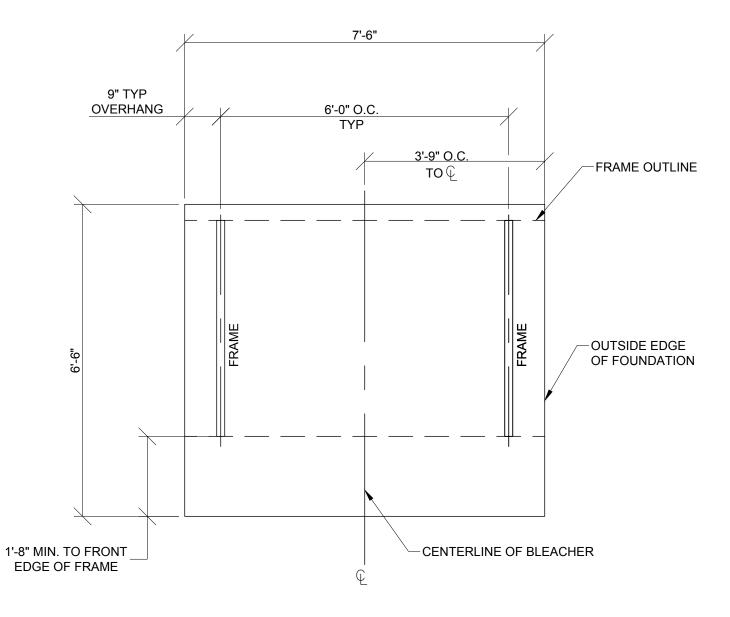

OPTIONAL FOUNDATION PLAN*

SCALE: 1/2" = 1' - 0"

* MINIMUM FOUNDATION AREA SHOWN. DEPENDING ON LOCAL SOIL CONDITIONS, BLEACHER CAN BE INSTALLED ON A CONCRETE PAD OR FOOTERS, OR ATTACHED TO 2x6 TREATED LUMBER GROUND SILLS AND PLACED ON COMPACTED STONE, ASPHALT, OR ANY OTHER SMOOTH, SOLID, LEVEL SURFACE. CONSULT YOUR LOCAL CONCRETE CONTRACTOR TO DETERMINE PROPER CONCRETE SPECIFICATIONS FOR YOUR LOCAL SOIL AND WEATHER-RELATED CONDITIONS. THE BEARING SURFACE MUST BE CAPABLE OF SUPPORTING A MINIMUM OF 660 POUNDS PER LINEAR FOOT. TO MEET LOCAL CODES, BLEACHERS WILL NEED TO BE ANCHORED. ANCHORING SYSTEMS FOR ALL SURFACE TYPES ARE AVAILABLE - CONTACT YOUR BLEACHER SALES REPRESENTATIVE FOR MORE INFORMATION.



GT GRANDSTANDS*

FOUNDATION PLAN 3 ROW BLEACHER 6" RISER/I2" SEAT

LU-037.5AD LU SERIES

DRAWN BY
MME
CHECKED BY
TLC
DATE
II/01/2016
SCALE
I/2" = I' - 0"
JOB NO.

LU-037.5AD

FP.1